PROPOSED NEW RESIDENCE

at

Lot 58 Mantello Drive, Werribee, Vic, 3030.

for:

Persaud Homes.

GENERAL NOTES:

ALL MATERIALS AND WORK PRACTICES SHALL COMPLY WITH, BUT NOT LIMITED TO THE BUILDING REGULATIONS 2006, THE BUILDING CODE OF AUSTRALIA, LOCAL BY-LAWS, TOWN PLANNING REQUIREMENTS AND ALL RELEVANT CURRENT AUSTRALIAN STANDARDS.

THESE DRAWINGS HAVE BEEN PREPARED FOR THE EXCLUSIVE USE OF THE CLIENT, FOR THE PURPOSE EXPRESSLY NOTIFIED TO THE DESIGNER. ANY OTHER PERSON WHO USES OR RELIES ON THESE DRAWINGS WITHOUT THE DESIGNERS WRITTEN CONSENT DOES SO AT THEIR OWN RISK – AND NO RESPONSIBILITY IS ACCEPTED BY THE DESIGNER FOR SUCH USE AND/OR RELIANCE.

THE APPROVAL BY THIS OFFICE OF A SUBSTITUTE MATERIAL, WORK PRACTICE, VARIATION OR THE LIKE IS NOT AN AUTHORISATION FOR ITS USE OR A CONTRACT VARIATION. ANY SAID VARIATIONS MUST BE ACCEPTED BY ALL PARTIES TO THE AGREEMENT, AND WHERE APPLICABLE, THE RELEVANT BUILDING SURVEYOR PRIOR TO IMPLEMENTING THE SAID VARIATION.

DO NOT SCALE THIS DRAWING – FIGURED DIMENSIONS TO TAKE PRECEDENCE OVER SCALE. BUILDERS AND CONTRACTORS TO VERIFY ALL DIMENSIONS, LEVELS, BUILDING ENVELOPES, AREAS AND SPECIFICATIONS PRIOR TO THE ORDERING OF ANY MATERIALS OR THE COMMENCEMENT OF ANY WORKS. IF DISCREPANCIES OCCUR – CONTACT THIS OFFICE IMMEDIATELY.

- -ALL MEASUREMENTS ARE IN MILLIMETERS UNLESS OTHERWISE INDICATED.
 ALL SITE LEVELS ARE IN METERS, UNLESS OTHERWISE INDICATED.
- -THE BUILDER MUST TAKE ALL STEPS NECESSARY TO ENSURE THE STABILITY AND GENERAL WATER TIGHTNESS OF NEW AND EXISTING STRUCTURES DURING ALL CONSTRUCTION WORKS.
- -THE BUILDER MUST TAKE ALL NECESSARY PRECAUTIONS TO ENSURE THE SAFETY OF ALL PERSONS WITHIN THE BUILDING SITE.

INSTALLATION OF ALL SERVICES SHALL COMPLY WITH THE RESPECTIVE SUPPLY AUTHORITY REQUIREMENTS.

ALL DRAWINGS DENOTED WITH "DRAFT" OR "PRELIMINARY" ARE STRICTLY ONLY FOR USE BETWEEN THIS OFFICE AND THE CLIENT. THESE DRAWINGS ARE NOT FOR PERMIT APPROVAL, QUOTATION OR TO BE USED BY BUILDERS. WORKING DRAWINGS TO BE READ IN CONJUNCTION WITH ENGINEERS DRAWINGS, SPECIFICATIONS AND COMPUTATIONS AND ALL OTHER DOCUMENTATION PROVIDED.

THESE NOTES ARE NEITHER EXHAUSTIVE NOR A SUBSTITUTE FOR REGULATIONS, STATUTORY REQUIREMENTS, BUILDING PRACTICE OR CONTRACTUAL OBLIGATIONS AND UNLESS EXPRESSLY STATED OTHERWISE, ARE PROVIDED ONLY AS GUIDELINES.

GLAZING:

- -ALL GLAZING MUST COMPLY WITH AS.1288
- -ALL GLAZING MUST BE INSTALLED TO COMPLY WITH AS.1288
 ALL GLAZING, INCLUDING SAFETY GLAZING, SHALL BE INSTALLED TO A SIZE,
 TYPE AND THICKNESS SO AS TO COMPLY WITH:
- BCA PART 3.6 FOR CLASS 1 & 10 BUILDINGS WITH A DESIGN WIND SPEED OF NOT MORE THEN N3, AND BCA PART B1.4 FOR CLASS 2-9 BUILDINGS.
- -WINDOW SIZES TO BE VERIFIED ON SITE PRIOR TO ORDERING.
- -WINDOW MEASUREMENT INDICATED MAY VARY FROM MANUFACTURERS SIZES. BUILDER TO PLACE ORDER WITH SELECTED WINDOW MANUFACTURER BASED ON MANUFACTURERS SIZES WITHIN CLOSE PROXIMITY OF THE SCHEDULED SIZE.

-ALL MASONRY CONSTRUCTION TO COMPLY WITH AS.3700 AND THE BUILDING CODE OF AUSTRALIA.

- -ALL DAMP PROOF COURSES AND FLASHINGS MUST BE IN ACCORDANCE WITH AS 2904
- -STRUCTURAL STEEL WORK MUST BE IN ACCORDANCE WITH AS.4100.
 -ALL TIMBER FRAMING MUST BE IN ACCORDANCE WITH AS.1684. PROVIDE DOUBLE STUDS TO ALL OPENINGS GREATER THEN 1500mm.
- -PROVIDE BRACING TO ALL INTERNAL AND EXTERNAL WALLS AS PER AS.1684.

SUB- FLOOR VENTS TO PROVIDE A RATE OF 6000mm Sq. CLEAR VENTILLATION PER 1000mm RUN OF EXTERNAL MASONRY WALL AND 22000mm Sq. CLEAR VENTILLATION PER 1000mm RUN OF INTERNAL DWARF WALLS. ALL SUB-FLOOR PLYNTH BOARDS TO BE LOCATED BELOW THE LEVEL OF THE BEARER.

CONVENTIONAL TIIMBER FLOOR CONSTRUCTION TO ENGINEERS DETAILS & COMPUTATIONS PROVIDE CLEARANCE FROM UNDERSIDE OF BEARER TO FINISHED GROUND LEVEL OF 150mm FOR FLOORS WITH STRIP FLOORING AND 200mm FOR FLOORS WITH PARTICLE BOARD FLOORING. REFER TO PART 3.4.1 DIAGRAM B OF TH BCA FOR SUB-FLOOR VENTILATION DETAILS.

ROOF TRUSSES:

ALL ROOF TRUSSES ARE TO BE CONSTRUCTED AND ASSEMBLED AS PER THE MANUFACTURERS DESIGN AND SPECIFICATIONS. MANUFACTURERS COMPUTATIONS ARE TO BE PROVIDED PRIOR TO FRAME INSPECTION.

STAIRS, LANDINGS & BALUSTRADES:

STEP SIZES (OTHER THEN SPIRAL STAIRS) TO BE:

- -RISERS (R) AT 190mm MAXIMUM AND 115mm MINIMUM
- -GOING (G) 355mm MAXIMUM AND 240mm MINIMUM -GAPS BETWEEN RISERS TO NOT EXCEED 125mm

ALL TREADS, LANDINGS AND THE LIKE TO HAVE A NON-SLIP FINISH OR SUITABLE NON-SKID STRIP NEAR EACH NOSING.

PROVIDE BALUSTRADES WHERE CHANGE IN LEVEL EXCEEDS 1000mm ABOVE THE SURFACE BENEATH LANDINGS, RAMPS AND/OR TREADS. BALUSTRADES (OTHER THEN WIRE) TO BE:

- -1000mm ABOVE FINISHED SURFACE LEVEL OR BALCONIES AND LANDINGS OR THE LIKE, AND 865mm MIN ABOVE FINISHED SURFACE LEVEL OF STAIR NOSINGS
- -VERTICAL WITH LESS THEN 125mm GAP BETWEEN.
- -ANY HORIZONTAL ELEMENT WITHIN THE BALUSTRADE BETWEEN 150mm AND 760mm ABOVE THE FINISHED SURFACE LEVEL MUST NOT FACILITATE CLIMBING WHERE CHANGES IN LEVEL EXCEEDS 4000mm ABOVE THE SURFACE BENEATH LANDINGS, RAMPS OR TREADS.

WIRE BALUSTRADE CONSTRUCTION TO COMPLY WITH BCA VOL.2 PART 3.9.2.3 FOR CLASS 1–10 BUILDINGS AND BCA VOL.1 PART D2.16 FOR OTHER CLASSES OF BUILDINGS.

LANDINGS NEED ONLY BE PROVIDED WHERE A DOORWAY OPENS ONTO A STAIR
THAT PROVIDES A CHANGE IN FLOOR LEVEL GREATER THEN 570mm.

<u>INSULATIO</u>

THESE DRAWINGS ARE TO BE READ IN CONJUNCTION WITH APPROVED STAMPED PLANS WHICH HAVE BEEN ASSESSED BY AN ACCREDITED THERMAL ASSESSOR. PROVIDE INSULATION AND GLAZING SPECIFICATIONS AS PER THE THERMAL ASSESSMENT REPORT.

TERMITE AND CORROSION PREVENTION:

WHERE THE BUILDING IS LOCATED IN A TERMITE PRONE AREA, THE AREA TO THE UNDERSIDE OF THE BUILDING AND THE PERIMETER IS TO BE TREATED AGAINST TERMITE ATTACK. AS PER AS.3660.1

PROVIDE CORROSION PROTECTION OF BUILT IN STRUCTURAL STEEL MEMBERS SUCH AS STEEL LINTELS, SHELF ANGLES, CONNECTORS AND ACCESSORIES IN ACCORDANCE WITH BCA VOL.2 TABLE 3.3.3.2.

PROVIDE CORROSION PROTECTION FOR SHEET ROOFING IN ACCORDANCE WITH BCA VOL.2 TABLE 3.5.1.

BUSHFIRE DESIGN INFORMATION:

THESE DRAWINGS MUST BE READ IN CONJUNCTION WITH THE BUSHFIRE ASSESSMENT REPORT FOR THE SITE. THIS REPORT REFERS TO AS.3959.2009, WHICH SPECIFIES THE NECESSARY CONSTRUCTION METHODS AND MATERIALS REQUIRED FOR EACH SITE. IF THE DRAWING SPECIFICATIONS DO NOT CORRELATE WITH THE BUSHFIRE REPORT – CONTACT THIS OFFICE.

STORM WATER AND DRAINAGE:

STORM WATER DRAINS TO BE CONNECTED TO THE EXISTING LEGAL POINT OF DISCHARGE OR AS DIRECTED BY COUNCILS ENGINEERING DEPARTMENT.

INSPECTION OPENINGS TO BE AT 9000mm CTRS AND AT EACH CHANGE OF DIRECTION

PROVIDE 100mm DIA UPVC PIPES

PROVIDE 75mm DIA DOWNPIPES

PROVIDE A MINIMUM FALL GRADIENT OF 1:100

BASE OF PIPES TO HAVE CRUSHED ROCK WITH A MINIMUM OF 50mm COVER.

THE COVER TO UNDERGROUND STORM WATER DRAINS TO BE NOT LESS THAN:

100mm LINDER SOII

50mm UNDER PAVED OR CONCRETE AREAS

OF ANY BUILDING AND ITS FOOTING SYSTEM.

100mm UNDER UN-REINFORCED CONCRETE OR PAVED DRIVEWAYS
75mm UNDER REINFORCED CONCRETE DRIVEWAYS

ALL BOX GUTTERS TO BE A MINIMUM OF 100mm x 200mm UNLESS OTHERWISE SPECIFIED - 1:100 GRADE MINIMUM - ADJUST TO SUIT ON SITE.

SEWER AND SEPTIC SYSTEMS TO BE IN ACCORDANCE WITH AS.3500

ALL SURFACE WATER RUN-OFF MUST BE CONTAINED WITHIN THE PROPERTY BOUNDARIES AND DISCHARGED TO THE STORM WATER SYSTEM.

THE BUILDER AND SUB-CONTRACTOR SHALL ENSURE THAT ALL STORM WATER DRAINS, SEWERS AND THE LIKE ARE LOCATED AT A SUFFICIENT DISTANCE FROM ANY BUILDINGS FOOTING AND/OR SLAB EDGE BEAMS SO AS TO PREVENT

GENERAL MOISTURE PENETRATION, DAMPNESS, WEAKENING AND UNDERMINING

WATERPROOFING:

WATERPROOFING OF WET AREAS, BEING BATHROOMS, SHOWERS, LAUNDRIES AND SANITARY COMPARTMENTS AND THE LIKE SHALL BE PROVIDED IN ACCORDANCE WITH AS.3740 - WATERPROOFING OF WET AREAS IN RESIDENTIAL BUILDINGS.

OTHER GENERAL NOTES:

(SA) DENOTES THE LOCATION OF SMOKE ALARMS. THESE ARE TO BE PROVIDED AND INSTALLED IN ACCORDANCE WITH AS.3786. THE SMOKE ALARM SHALL BE HARD WIRED WITH A BATTERY BACK-UP.

(EF) DENOTES THE LOCATION OF EXHAUST FANS. DUCT ALL EXHAUST FANS TO OUTSIDE AIR WHERE POSSIBLE – OR, AN EXHAUST FAN OF RATING 140/S MIN TO BE DISCHARGED INTO A VENTILATED ROOF SPACE WITH MIN 1000mm HORIZONTAL DUCT – IN ACCORDANCE WITH AS.1668. EXTERNAL DISCHARGE RATE MINIMUM 251/S.

SANITARY COMPARTMENT DOORS MUST EITHER - OPEN OUTWARDS, SLIDE OR BE READILY REMOVABLE FROM THE OUTSIDE UNLESS A MINIMUM CLEARANCE OF 1200mm BETWEEN THE DOOR AND THE PAN IS ACHIEVED.

DESCRIPTION

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PLEASE NOTE: The plan/s that are being provided to you

of enabling its consideration and review as part of a plann

process under the Planning and Environment Act 1987. The

may not reflect what is ultimately approved by Council however they are the most recent version as at the date shown below:

Date Plans Provided: 5/07/2017

WINDOW SCHEDULE				
NO.	SIZE (hxw)	HEAD HEIGHT	LOCATION	DESCRIPTION
W1	2100×820	2100 a.f.l	Entry	820 Timber Framed entry door (chk. on site)
W2	2100×600	under eave	Bedroom 2	Aluminum framed clear glazed awning window
W3	2100×600	under eave	Bedroom 2	Aluminum framed clear glazed awning window
W4	1200×1500	2100 a.f.l	Bathroom	Aluminum framed obscure glazed sliding window
W5	1000×600	2100 a.f.l	Wc	Aluminum framed obscure glazed sliding window
W6	1200×1500	2100 a.f.l	Bedroom 3	Aluminum framed clear glazed sliding window
W7	1200×1500	2100 a.f.l	Bedroom 4	Aluminum framed clear glazed sliding window
W8	1800×1800	2100 a.f.l	Dining/Family	Aluminum framed clear glazed sliding window
W9	600×1800	2100 a.f.l	Dining/Family	Aluminum framed clear glazed sliding window
W10	2100×1800	2100 a.f.l	Dining/Family	Aluminum framed clear glazed sliding door (2 panel)
W11	1200×1500	2100 a.f.l	Kitchen	Aluminum framed clear glazed sliding window
W12	1800×900	2100 a.f.l	Master Bed	Aluminum framed clear glazed sliding window
W13	1800×900	2100 a.f.l	Master Bed	Aluminum framed clear glazed sliding window
W14	1000×600	2100 a.f.l	Ensuite	Aluminum framed obscure glazed sliding window
W15	2100×1450	2100 a.f.l	Laundry	Aluminum framed clear glazed sliding door (2 panel)

NOTE:

WINDOW MEASUREMENTS INDICATED MAY VARY FROM WINDOW MANUFACTURER SIZES. BUILDER TO PLACE ORDER WITH WINDOW MANUFACTURER WITH STANDARD SIZES THAT MATCH THE ABOVE MEASUREMENTS WITHIN CLOSE PROXIMITY. WINDOW SIZES TO BE VERIFIED ON SITE PRIOR TO PLACING ORDER WITH MANUFACTURER ANY DISCREPANCIES PLEASE CONTACT OFFICE IMMEDIATELY NOTE: ALL GLAZING MUST COMPLY WITH AS.1288

SITE & AREA ANALYSIS

SITE (APPROX) 274sq/m
SITE COVERAGE 52.56% approx.

DWELLING AREAS
LIVING 118.42sq/m
PORCH 2.00sq/m
GARAGE 23.60sq/m

DRAWING SCHEDULE:

MYNDHAM GATT GOLUNGH

Project: PROPOSED RESIDENCE

At: Lot 58 Mantello Drive, Werribee, Vic, 3030.

For: **Persaud Homes**



9467 6954 / 0403 568 160 - New Homes Suite 14/19 Enterprise Drive Bundoora 3083 - Unit Develorm

ifo@msdesignerliving.com.au

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**OD NOT SCALE THIS DRAWING

VERY SCALE. BUILDERS TO CONFIRM
DIMENSIONS ON SITE PRIOR TO COMMENCMENT
OF WORKS

NOTE:

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NOTE: SITE & FLOOR LEVELS TO BE CONFIRMED ON SITE BY BUILDER PRIOR TO COMMENCEMENT OF ANY WORKS COMMENCEMENT OF ANY WORKS

	NORTH
DATE	

TOTAL

Date. 28-

144.02sq/m 15.50sq's

Date. 28-02-17

(hecked MM

1 Sheet No. A01

Job No. 20171090 WORKING DRAWING

DOWNPIPE LEGEND

■ dp 100 x 50mm COLORBOND DOWNPIPE

BG1 100 x 400mm COLORBOND BOX GUTTER. ADJUST ON SITE.

ALL DOWNPIPES SHALL HAVE MAXIMUM SPACING OF 12M. (unless noted otherwise)

ightarrow roof fall direction

SURFACE WATER MUST BE DIVERTED AWAY FROM THE DWELLING AND GRADED AWAY FROM ALL FOUNDATIONS TO GIVE A SLOPE OF NOT LESS THAN 50MM OVER THE FIRST 1000MM FROM THE DWELLING

SUBSURFACE DRAINS TO REMOVE GROUND OR TABLE WATER SHALL BE DETAILED BY THE DESIGN ENGINEER. FURTHERMORE DAMP-PROOFING MEMBRANE IN ACCORDANCE WITH 5.3.3 SHALL BE INSTALLED FOR GROUNDWATER OR AGGRESSIVE SOILS

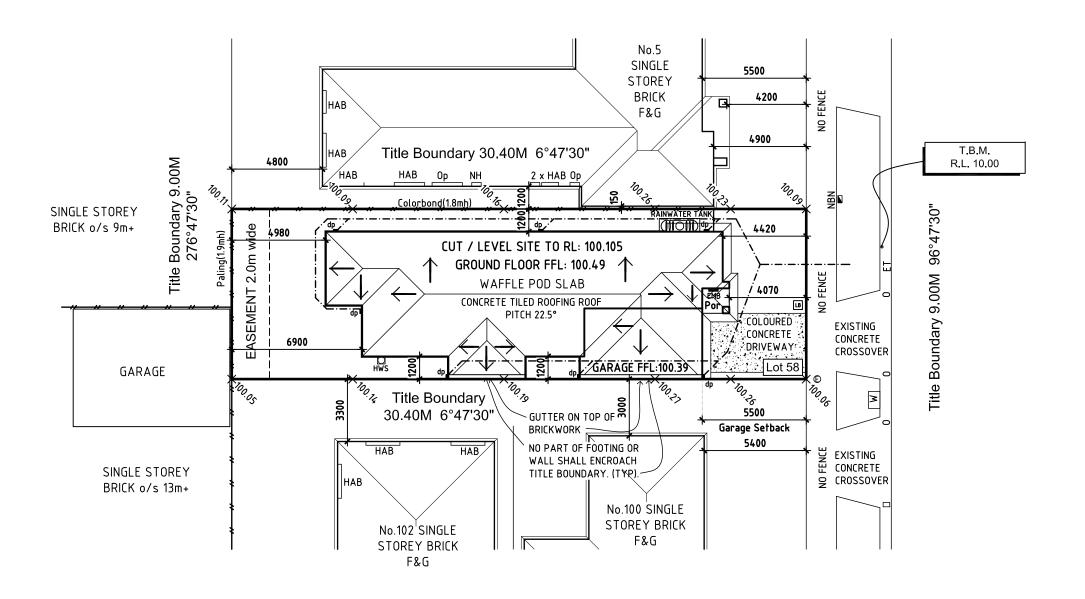
ALL SURFACE DRAINAGE WORKS SHALL BE INSTALLED IN ACCORDANCE WITH THE ENGINEERS DESIGN DETAILEOR THE SELECTED FOOTING SYSTEM AND SOIL CLASSIFICATION AND IN ACCORDANCE WITH CLAUSE 5.6.3 DRAINAGE REQUIREMENTS OF AS2870-2011, WHEREIN FOR BUILDINGS ON MODERATELY, HIGHLY AND REACTIVE SITES:

| ALL SURFACE DRAINAGE WORKS SHALL BE INSTALLED IN ACCORDANCE WITH THE ENGINEERS DESIGN DETAILEOR THE SELECTION FOR SYSTEM AND SOIL CLASSIFICATION AND IN ACCORDANCE WITH CLAUSE 5.6.3 DRAINAGE REQUIREMENTS OF AS2870-2011, WHEREIN FOR BUILDINGS ON MODERATELY, HIGHLY AND REACTIVE SITES:

- O SURFACE DRAINAGE SHALL BE CONTROLLED THROUGHOUT CONSTRUCTION PAND PECOMPRESE BY AND OF CONSTRUCTION.
- O THE BASE OF TRENCHES SHALL SLOPE AWAY FROM THE BUILDING.

O WHERE PIPES PASS UNDER THE FOOTING SYSTEMS, CLAYPEBASEARECADOPTED TO BREVE MIN ATHE MEDICES SIGN OF THE PIPES PASS UNDER THE FOOTING SYSTEMS, CLAYPEBASEARECADOPTED TO BREVE MIN ATHE MEDICES SIGN OF THE PIPES PASS UNDER THE FOOTING SYSTEMS, CLAYPEBASEARECADOPTED TO BREVE MIN ATHE MEDICES SIGN OF THE PIPES PASS UNDER THE FOOTING SYSTEMS, CLAYPEBASEARECADOPTED TO BREVE MIN ATHE MEDICES SIGN OF THE PIPES PASS UNDER THE FOOTING SYSTEMS, CLAYPEBASEARECADOPTED TO BREVE MIN ATHE MEDICES SIGN OF THE PIPES PASS UNDER THE FOOTING SYSTEMS, CLAYPEBASEARECADOPTED TO BREVE MIN ATHE MEDICES SIGN OF THE PIPES PASS UNDER THE P FOR BUILDINGS ON HIGHLY AND REACTIVE SITES, THE DRAINER SHALL BROWNE DRAINAGE ATTICHLATION TO ALL STORMWATER SANITARY
PLUMBING DRAINS AND DISCHARGE PIPES IN ACCORDANCE WITH CLAUSE 5.6.4 PLUMBING REQUIREMENTS, WHEREIN FLEXIBLE JOINTS
IMMEDIATELY OUTSIDE THE FOOTING AND COMMENCING WITHIN 114 DEVINE PRINCEPER ARE REQUIRED TO ACCOMMENCING WITHIN 114 DEVINE PRINCEPER ARE REQUIRED TO ACCOMMENDED TO ACCOMMEND TO ACCOMMENDED TO ACCOMMEND TO ACCOMMENDED TO ACCOMMEND TO ACCOMMENDED TO ACCOMMEND TO ACCOMMEND. REQUIRED DIFFERENTIAL MOVEMENT BASED ON THE SOIL CLASSIFICATION.

Date Plans Provided: 5/07/2017



ALL LEVELS SHOWN AS PROVIDED BY SURVEYOR AND ARE TO BE CONFIRMED ON SITE PRIOR TO CONSTRUCTION.

SITE / ROOF PLAN

Project: PROPOSED RESIDENCE

Lot 58 Mantello Drive. Werribee, Vic, 3030.

Persaud Homes. For:

MS designer living architectural design

9467 6954 / 0403 568 160 Suite 14/19 Enterprise Drive, Bundoora, 3083 - Unit Developminfo@msdesignerliving.com.au - Extensions ww.msdesignerliving.com.au

MIN. 1000mm U.P.V.C. SEWER DRAIN

CLASS "SH" CONNECTED INTO

LEGAL POINT OF DISCHARGE AS

DIRECTED BY LOCAL AUTHORITY.

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SITE & FLOOR LEVELS TO BE CONFIRMED ON SIT BY BUILDER PRIOR TO COMMENCEMENT OF ANY

DESCRIPTION

THIS SITE HAS BEEN ASSESSED UNDER

THE AUSTRALIAN STANDARD 3959-2009 FOR BUSHFIRE ATTACK LEVELS AND IS

PRONE AREA

Date. 28-02-17 Scale. 1:200@A3 Checked

NORTH

DATE

Sheet No.

Job No. 2017109

BUSHFIRE WARNING

WORKINGTRAWNES

PROVIDE 10mm EXPANSION JOINTS z lite Com Noberation and review (##BBR 151701) & RAMMING AS PER SOIL TEST REQUIREMENTS der the Planning and Environment Oct 1987. The IN MASONRY WALLS ABOVE OR The state of the second of the CLOSE TO JUNCTIONS BETWEEN; SMOKE ALARMS TO BE KEPT DIFFERENT TYPES OF FOOTING 300MM MIN. FROM WALLS, SYSTEMS, FOOTINGS FOUNDED A BULKHEADS, DOORWAYS ECT. AJ ARTICULATION SIGNIFICANTLY DIFFERENT PLEASE NOTE: JOINTS

PLEASE NOTE: The object of the control of the DEPTHS, OR FOOTINGS FOUNDED ON SIGNIFICANTLY DIFFERENT ALL SMOKE DETECTORS TO MATERIALS. (ie. CLAY & ROCK) BE HARDWIRED AND ALSO WHERE NEW BRICKWORK INTERCONNECTED IN ABUTTS EXISTING BRICKWORK. ACCORDANCE WITH NCC 2014 TPassePlans & roov is teck E54(07/100676 MPLY IN ACCORDANCE WITH THE ATTACHED ENERGY RATERS SPECIFICATION. 21000 510 510 7970 Dining / Family 90 2100 Bed 4 2700 Bed 3 90 1000 90 1800 Bath 2700 Bed 2 2220 Ent REINFORCED CONCRETE SLAB TO ALL GROUND ROOF TRUSSES AS PER MANUFACTURERS 600mm W X 2400mm L, MINIMUM 2000 LITRE SLIMLINE RAIN FLOORS. REFER TO DESIGN AND SPECIFICATIONS **ENGINEERS DRAWINGS FOR** WATER TANK TO HAVE A CATCHMENT AREA FROM A ROOF OF MANUFACTURERS COMPUTATIONS TO BE AT LEAST 50 SQUARE METRES AND TO BE CONNECTED TO ALL SIZES AND DETAILS. PROVIDED PRIOR TO FRAME INSPECTION. SANITARY FLUSHING SYSTEMS WITHIN THIS BUILDING. Title Boundary W06 A01 W08 A01 는 PROVIDE HANGING [**PROVIDE** ப் RAIL & SHELF ∕@ HANGING RAIL & Dining/Family Bed 4 8 2 1.8M OFF FFL 2640 Bath Bed 3 SHELF @ 1.8M Bath 🗔 Beď 2 OFF FFL 2520 3420 Dining / FFL :100.49 ∕ CH:2700 PROVIDE HANGING RENDERED BRICK PIERS. RAIL & SHELF @ 1.8M OFF FFL BEAM TO ENG' 8# ⁄1770 1500 1120 Ent. Ent laminex LIFT OFF HINGES SELECTED NON-SLIP 820 8 TILES TO PORCH 100mm STEP DOWN PROPOSED ELECTRIC METER BOX TO RELEVANT AUTHORITIES REQUIREMENTS. WIDE) ∥Ens⊡ REINFORCED CONCRETE FLOOR STRUCTURE TO GARAGE. REFER TO STRUCTURAL ENGINEERS Master Bed Garage 3500 DRAWINGS FOR ALL DETAILS AND SIZES. (TYP) FFL :100.39 CH:2800 PROVIDE 10mm THICK PLASTERBOARD LINING TO W14 A01 ΑJ W12 A01 ALL GARAGE INTERNAL WALLS. REFER TO MANUFACTURERS SPECIFICATIONS FOR DETAILS Title Boundary LΑ NO PART OF FOOTING OR WALL SHALL ENCROACH TITLE BOUNDARY. (TYP). 20 900 20 20 GUTTER ON TOP OF BRICKWORK 1350 90 1740 L'Dry 90 6000 Garage ON TITLE BOUNDARY. (TYP). 3870 Kitchen 3600 Master Bed 240 1080 35 Ens 1920 4560 4080 2880 6480 1430 Por BUILDER TO PROVIDE EVAPORATIVE COOLING AND DUCTED HEATING UNIT ALL FLOOR INTERNAL DOORS TO TRUSS MANUFACTURERS SPECIFICATIONS TO BE PROVIDED BE 2040mm HIGH, UNLESS OTHER PRIOR TO THEIR ERECTION AND LOADBEARING POINTS I.E LINTELS, STUDS SUPPORTING CONCERTRATED LOADS TO BE WISE NOTED. DESIGNED BY TRUSS MANUFACTURER AND/OR STRUCTURAL ENGINEER. IF STRUCTURAL DESIGN WAS PROVIDED THE RANGEHOOD IS TO BE EXTERNALLY SLIDING DOORS MUST BE **FLOOR PLAN** VENTED TO OUTSIDE AIR GRADE 'A' SAFETY GLASS REPRODUCTION OF THE HOLE OR PART OF THE DOCUME Date. 28-02-17 ×DO NOT SCALE THIS DRAWING Project: PROPOSED RESIDENCE FIGURED DIMENSIONS TO TAKE PRECEDENCE DISTITUTES AN INFRINGEMENT MS designer living OVER SCALE, BUILDERS TO CONFIRM RIGHT. THE INFORMATION, AS AND CONCEPTS CONTAINE DIMENSIONS ON SITE PRIOR TO COMMENCMENT Lot 58 Mantello Drive, architectural design Sheet No. THIS DOCUMENT IS / ARE Scale. 1:100@A3 Checked A03/07 NORTH ONFIDENTIAL. THE RECIPIENT(S HIS DOCUMENT IS / ARE ROHIBITED FROM DISCLOSING Werribee, Vic, 3030. 9467 6954 / 0403 568 160 SITE & FLOOR LEVELS TO BE CONFIRMED ON SIT BY BUILDER PRIOR TO COMMENCEMENT OF ANY ROHIBITED FROM DISCLOSING UCH INFORMATION , IDEAS AND ONCEPTS TO ANY PERSON JITHOUT PRIOR WRITTEN CONSE F MS DESIGNER LIVING PTY LTD Job No. 20171090 Suite 14/19 Enterprise Drive, Bundoora, 3083 - Unit Developm info@msdesignerliving.com.au - Extensions WORKINGTRAWNIGS

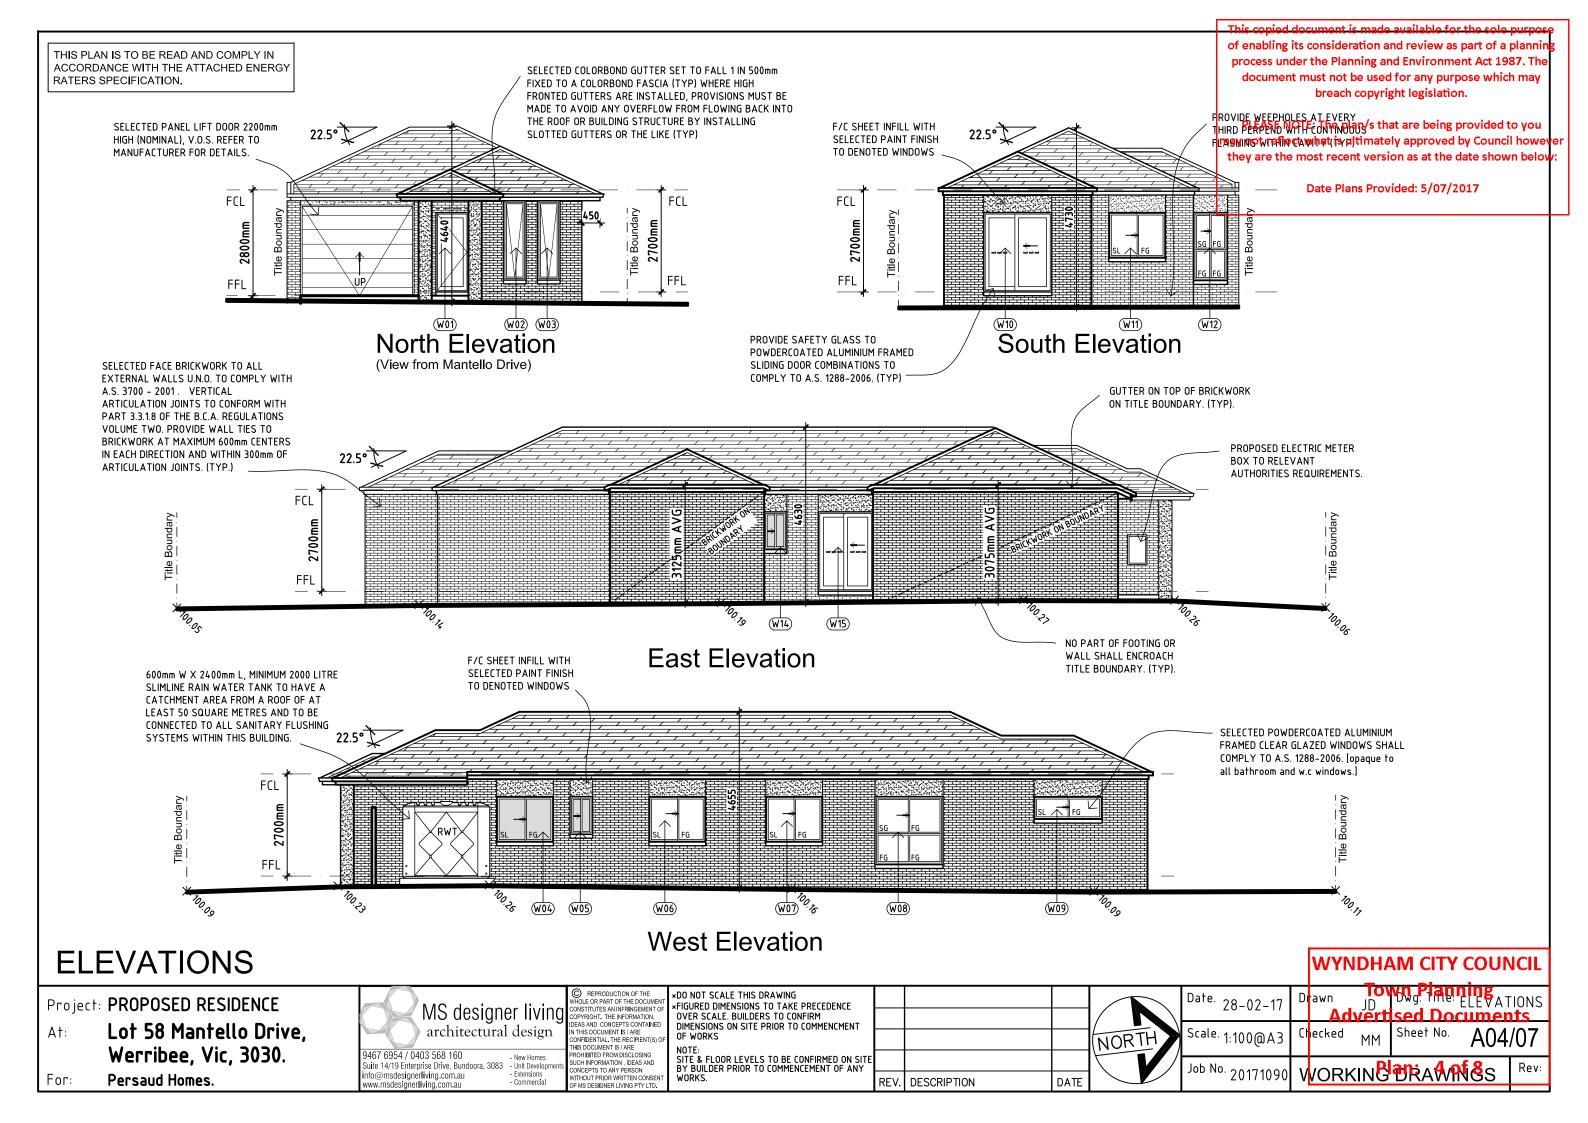
DESCRIPTION

DATE

For:

Persaud Homes

w msdesignerliving com au



EXTERNAL COLOUR & MATERIAL SCHEDULE

BRICKS

BRICK MORTAR

ROOF TILES

WINDOW FRAMES

FLY SCREENS

PORCH PIERS RENDER

GARAGE RENDER

GUTTERS

FASCIA

GARAGE DOOR

DOWN PIPES

METER BOX

DRIVEWAY

STRUCTUAL TIMBERWORK

ALL STRUCTUAL TIMBERWORK AND ASSOCIATED CONNECTIONS SHALL COMPLY WITH A.S. 1720 TIMBER STRUCTURES CODE. ALL TIMBER MEMBERS SHALL BE STRESS GRADED AND MARKED IN ACCORDANCE WITH A.S. 2858, A.S. 1748, A.S. 1749 AND B.C.A. ALL TIMBER FRAMING INCLUDING FLOORS, WALLS AND ROOF, SHALL COMPLY WITH AS 1684 TIMBER FRAMING CODE. ALL WALL BRACING SHALL BE IN

ACCORDANCE WITH A.S. 1684.

REFER TO TRUSS MANUFACTURERS DOCUMENTATION FOR ALL DETAILS ON PRE-FABRICATED ROOF FRAMING (TYP) @ 600 cts. ALL DIMENSIONS TO BE VERIFIED ON SITE PRIOR TO MANUFACTURE & INSTALLATION. STUDS:90X45 MGP10 AT GUTTER ON TOP OF 450 CRS WITH NOGGINS BRICKWORK ON TITLE AT 1350 MAX CRS BOUNDARY, (TYP). Detail 2 Detail 3 FCL FCL Garage Bed 2 Ent SOIL CLASSIFICATION REINFORCED CONCRETE SLAB NO PART OF FOOTING OR AS PER SOIL REPORT TO ALL FLOORS. REFER TO WALL SHALL ENCROACH

Section

Scale 1:100

of enabling its consideration and review as part of a plan process under the Planning and Environment Act 1987. The document must not be used for any purpose which may breach copyright legislation.

SELECTED CONCRET PHEASE WATE The plan/s that are being provided to you 22.5° PITCH. ROOM NORMAN AND FROM PHY India ultimately approved by Council however A.S. 2050 - 2002the Safe4the 3963st recent version as at the date shown below

Date Plans Provided: 5/07/2017

SECTION

SELECTED CONCRETE TILED ROOFING AT 22.5° PITCH. ROOFING SHALL COMPLY TO A.S. 2050 -

> REFER TO TRUSS MANUFACTURERS DOCUMENTATION FOR ALL DETAILS ON PRE-FABRICATED ROOF FRAMING (TYP) @ 600 cts. ALL DIMENSIONS TO BE VERIFIED ON SITE PRIOR TO MANUFACTURE & INSTALLATION.

2002 & A.S. 2049 - 2002. (TYP).

TITLE BOUNDARY. (TYP).

ROOF BATTENS: 38x75 F8 H.W. AT 330 CRS

SELECTED COLORBOND GUTTER SET TO FALL 1 IN 500mm FIXED TO A COLORBOND FASCIA (TYP) WHERE HIGH FRONTED GUTTERS ARE INSTALLED, PROVISIONS MUST BE MADE TO AVOID ANY OVERFLOW FROM FLOWING BACK INTO INTO THE ROOF OR BUILDING STRUCTURE BY INSTALLING SLOTTED GUTTERS OR THE LIKE (TYP)

10mm PLASTERBOARD WALL & CEILING LINING, FOR FIXING REFER TO MANUFACTURERS DETAILS. STUDS AT 450 MAX. CENTRES. (TYP)

STUDS:90X45 MGP10 AT 450 CRS WITH NOGGINS AT 1350 MAX CRS

SELECTED FACE BRICKWORK WITH REFLECTIVE FOIL SARKING TO ALL EXTERNAL WALLS U.N.O. TO COMPLY WITH A.S. 3700 - 2001 VERTICAL ARTICULATION JOINTS TO CONFORM WITH PART 3.3.1.8 OF THE B.C.A.

SELECTED CONCRETE TILED ROOFING AT 22.5° PITCH. ROOFING SHALL COMPLY TO A.S. 2050 - 2002 & A.S. 2049 - 2002.

A-A

А3

REFER TO TRUSS MANUFACTURERS DOCUMENTATION FOR ALL DETAILS ON PRE-FABRICATED ROOF FRAMING (TYP) @ 600 cts. ALL DIMENSIONS TO BE VERIFIED ON SITE PRIOR TO MANUFACTURE & INSTALLATION.

ROOF BATTENS: 38x75 F8 H.W. AT 330 CRS

100 QUAD SPOUT ON BOUNDARY WALL

-FLASHING AS REQUIRED

NON-COMBUSTIBLE INSULATION UNDER **ROOF COVERING**

SELECTED FACE BRICKWORK WITH REFLECTIVE FOIL SARKING TO ALL EXTERNAL WALLS U.N.O. TO COMPLY WITH A.S. 3700 - 2001. VERTICAL ARTICULATION JOINTS TO CONFORM WITH PART 3.3.1.8 OF THE B.C.A.

Detail - 2 Scale 1:20

REV.

DESCRIPTION

SELECTED CONCRETE TILED ROOFING AT 22.5° PITCH, ROOFING SHALL COMPLY TO A.S. 2050 -2002 & A.S. 2049 - 2002. (TYP).

REFER TO TRUSS MANUFACTURERS DOCUMENTATION FOR ALL DETAILS ON PRE-FABRICATED ROOF FRAMING (TYP) @ 600 cts. ALL DIMENSIONS TO BE VERIFIED ON SITE PRIOR TO MANUFACTURE & INSTALLATION.

ROOF BATTENS: 38x75 F8 H.W. AT 330 CRS

SELECTED COLORBOND **GUTTER SET TO FALL 1 IN** 500mm FIXED TO A COLORBOND FASCIA (TYP)

10mm PLASTERBOARD WALL & CEILING LINING, FOR FIXING REFER TO MANUFACTURERS DETAILS. STUDS AT 450 MAX. CENTRES. (TYP)

STUDS:90X45 MGP10 AT 450 CRS WITH NOGGINS AT 1350 MAX CRS

Detail - 3

ENGINEERS DRAWINGS FOR

SIZES AND DETAILS (TYP)

DETAILS

Detail - 1

Lot 58 Mantello Drive. Werribee, Vic, 3030.

Persaud Homes.



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SITE & FLOOR LEVELS TO BE CONFIRMED ON SIT BY BUILDER PRIOR TO COMMENCEMENT OF ANY



DATE

Date. 28-02-17 ^{Scale.} As Noted

450 EAVE

Checked

Sheet No.

A05/07

WYNDHAM CITY COUNCIL

Job No. 20171090

WORKINGTRAWNES

Project: PROPOSED RESIDENCE

SPECIFICATIONS:

REINFORCED CONCRETE SLAB TO ALL GROUND FLOORS. REFER TO ENGINEERS DRAWINGS FOR SIZES AND DETAILS

FLOORING:

FLOOR FINISHES AS SELECTED BY CLIENT.

WALL FRAMING:

FRAMING MUST BE IN ACCORDANCE WITH AS.1684. BOTTOM PLATE- 90x45 MGP10

90x45 MGP10 AT 450 CTRS STUDS-

2 / 90x45 MGP10 IAMB STUDS.

70x35 MERCH AT 1350 CTRS MAX NOGGINS-

TOP PLATE-2 / 90x45 MGP10 LINTELS TO ENGINEERS DESIGN AND SPECIFICATION.

ROOF FRAMING:

ROOF TRUSSES AS PER MANUFACTURERS DESIGN AND SPECIFICATIONS. MANUFACTURERS

COMPUTATIONS ARE TO BE PROVIDED PRIOR TO FRAME INSPECTION.

BUILDING TO CONFIRM EAVES DO NOT CLASH WITH WINDOWS OR MOLDS PRIOR TO ORDERING TRUSSES.

ROOF BATTENS: 38x75 F8 HW AT 330 CTRS (TILE) 38x75 F8 HW AT 900 CTRS

38x75 F8 HW AT 900 CTRS (KLIP-LOK)

ROOFING TYPE:

SELECTED CONCRETE TILED ROOF PITCH 22.5°

EXTERNAL FINISHES:
ALL MATERIALS AND FINISHES TO CLIENTS

SPECIFICATION.

- SELECTED FACE BRICKWORK TO CLIENTS SPECIFICATION WHERE INDICATED.

- SELECTED SMOOTH RENDER FINISH TO CLIENTS

SPECIFICATION WHERE INDICATED. **INTERNAL WALL FINISHES:**

10mm PLASTERBOARD TO BE PAINTED (ALL INTERNAL WALLS)

10mm PLASTERBOARD TO BE PAINTED (ALL

INTERNAL CEILINGS)

CLIENT TO SELECT SQUARE FINISH OR CORNICE FOR EACH ROOM.

WET AREAS:

ALL WET AREAS TO HAVE IMPERVIOUS FINISH TO FLOOR AND WALLS (TILES) IN ACCORDANCE WITH THE BUILDING CODE OF AUSTRALIA AND

AS.3740.2004

CLOSE PROXIMITY.

SHOWERS TO 2100a.f.l MIN

SINKS, TROUGHS AND HAND BASINS - 300mm MIN WINDOWS:

ALL WINDOW SIZES, TYPES AND COLORS MUST BE IN ACCORDANCE WITH ENDORSED TOWN PLANNING DOCUMENTS.

WINDOW MEASUREMENTS INDICATED MAY VARY FROM THE WINDOW MANUFACTURERS SIZES. BUILDER TO PLACE ORDER WITH WINDOW MANUFACTURER WITH STANDARD SIZES THAT MATCH THE NOMINATED MEASUREMENTS WITH

WINDOW SIZES TO BE VERIFIED ON SITE BEFORE PLACING ORDER WITH MANUFACTURER. IF ANY DISCREPANCIES ARE FOUND, PLEASE CONTACT THIS OFFICE IMMEDIATELY.

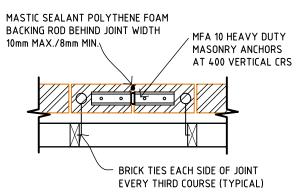
BUILDER TO CONFIRM WINDOW HEAD HEIGHTS DO NOT CLASH WITH ANY MOLDS OR EAVES PRIOR TO PLACING ORDER WITH MANUFACTURER. GLAZING:

ALL GLAZING SHALL COMPLY WITH THE AUSTRALIAN BUILDING CODE, FOR CLASS 1&10 BUILDINGS WITH A DESIGN WIND SPEED OF NOT MORE THEN N3. FOR CLASS 2 TO 9 BUILDINGS REFER TO THE BUILDING CODE OF AUSTRALIA PART B1.4 AND AS.1288 & AS.2047.


ALL GLAZING SPECIFICATIONS TO BE IN ACCORDANCE WITH THE APPROVED THERMAL ASSESSMENT. BUILDER TO CONFIRM WINDOW SPECIFICATION PRIOR TO PLACING ORDER WITH MANUFACTURER.

INSULATION: PROVIDE INSULATION IN ACCORDANCE WITH THE THERMAL ASSESSMENT PROVIDED BY AN ACCREDITED ASSESSOR

PROVIDE FULL HEIGHT ARTICULATION JOINTS TO BRICKWORK AT 6000mm max CTRS OR AS STATED ON GEOTECHNICAL & SITE INVESTIGATION REPORT



Brick Articulation Detail Not to scale

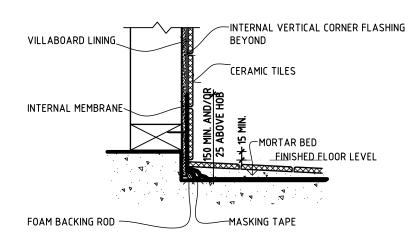


Scale 1:5

of enabling its consideration and review as part of a plan process under the Planning and Environment Act 1987. The document must not be used for any purpose which may breach copyright legislation.

PLEASE NOTE: The plan/s that are being provided to you may not reflect what is ultimately approved by Council however they are the most recent version as at the date shown below:

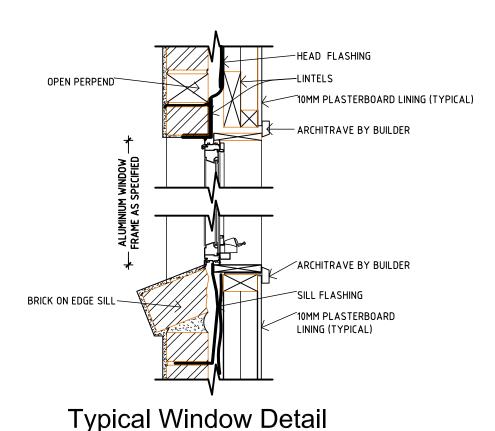Date Plans Provided: 5/07/2017



Typical Wet Area Set-Down Details At Slab

DETAILS

Project: PROPOSED RESIDENCE

Lot 58 Mantello Drive. Werribee, Vic, 3030.

For: Persaud Homes.



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DESCRIPTION DATE



Scale 1:10

Date. 28-02-17 ^{Scale.} As Noted

Sheet No. Checked

A06/07

WORKING TRANSS

THIS PLAN IS TO BE READ AND

COMPLY IN ACCORDANCE WITH

THIS PLAN IS TO BE READ AND COMPLY IN ACCORDANCE WITH THE ATTACHED ENERGY RATERS SPECIFICATION.

NOTES:

PROVIDE LIGHT & POWER FOR HEATER UNIT WITHIN ROOF SPACE NEAR ROOF ACCESS.

PROVIDE POWER POINT WITHIN ROOF SPACE FOR COOLING

ALL EXTERNAL FITTINGS TO BE

PROVIDE ONE 15 AMP DOUBLE POWER POINT TO THE GARAGE AS INDICATED

INSTALL ALARM SYSTEM TO BUILDERS SPECIFICATION.

BUILDER TO PROVIDE ENERGY METERING DEVICE WITH IN HOME DISPLAY (ie. CLIPSAL CENT-A-METER)

SA DENOTES LOCATIONS OF SMOKE ALARMS TO BE PROVIDED AND INSTALLED IN ACCORDANCE WITH A.S. 3786-1993 & UNLESS INSTALLED IN AN EXISTING PART OF A CLASS document of the control of the contr 1, 2 OR 3 BUILDING OR A CLASS 4 PART OF A BUILDING, THE SMOKE ALARM SHALL BE HARD WIRED WITH BATTERY BACKUP.


EF DENOTES: CEILING EXHAUST FAN PROVIDE A LIGHT AND AN EXHAUST FAN WHERE PLEASE NOTE: The plan/s that are being provided to you NATURAL LIGHTING AND VENTILATION IS NOT PROVIDED WHERE REQUIRED BY LOCAL A DIENOROTY OF LOCAL AND A SUIT MATERIAL PROVIDED WHERE REQUIRED BY LOCAL A DIENOROTY OF LOCAL AND A PROVIDED WHERE REQUIRED BY LOCAL A DIENOROTY OF LOCAL AND A PROVIDED WHERE REQUIRED BY LOCAL ADDRESS OF LOCAL AND A PROVIDED WHERE REQUIRED BY LOCAL ADDRESS OF LOCAL AND A PROVIDED WHERE REQUIRED BY LOCAL ADDRESS OF LOCAL AND A PROVIDED WHERE REQUIRED BY LOCAL ADDRESS OF LOCAL ADDR DUCT THE EXHAUST TO THE OUTSIDE. they are the most recent version as at the date shown below:

Date Plans Provided: 5/07/2017

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copyright legislation. CEILING LIGHT POINT

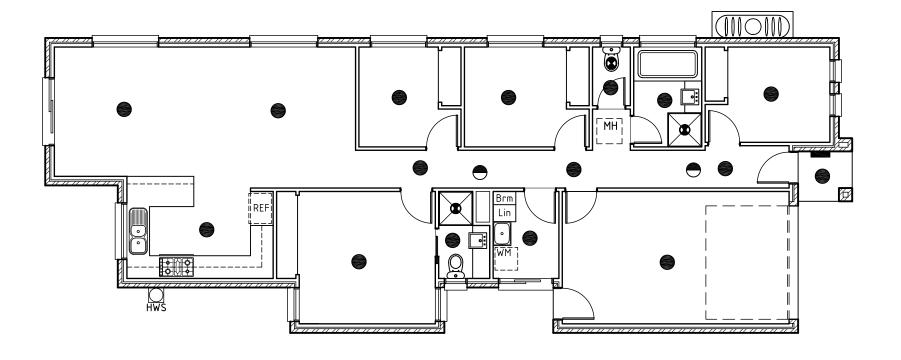Planning and Environment Act 1987. The



LIGHTING NOT TO EXCEED 5 WATTS PER SQUARE METER FOR LIVING AREAS IN ACCORDANCE WITH BCA 2012.

LIGHTING NOT TO EXCEED 3 WATTS PER SQUARE METER FOR GARAGE IN ACCORDANCE WITH BCA 2012.

LIGHTING CALCULATOR

Project: PROPOSED RESIDENCE

Lot 58 Mantello Drive, Werribee, Vic, 3030.

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NORTH

Date. 28-02-17 Scale. 1:100@A3 Checked

Max allowabel wattage $-(5W/m^2)$

WORKINGTRAWNES

Job No. 20171090 DESCRIPTION DATE

For:

Persaud Homes.

Internal of dwelling - (Class 1) Dwelling floor areas: 118.42 sg/m Total light fitting wattage proposed 560 watts

4.72 watts

Artificial Lighting Calculator (To be installed in accordance with AS/NZ 1680 - 2009)

Internal garage areas: 23.60sg/m Total light fitting wattage proposed 40.00 watts 1.73 watts Max allowabel wattage $-(3W/m^2)$

2.00 sq/m Porch areas:



CORDYLINE FRUTICOSA RUBRA



CORDYLINE RED STAR



DIANELLA DESTINY

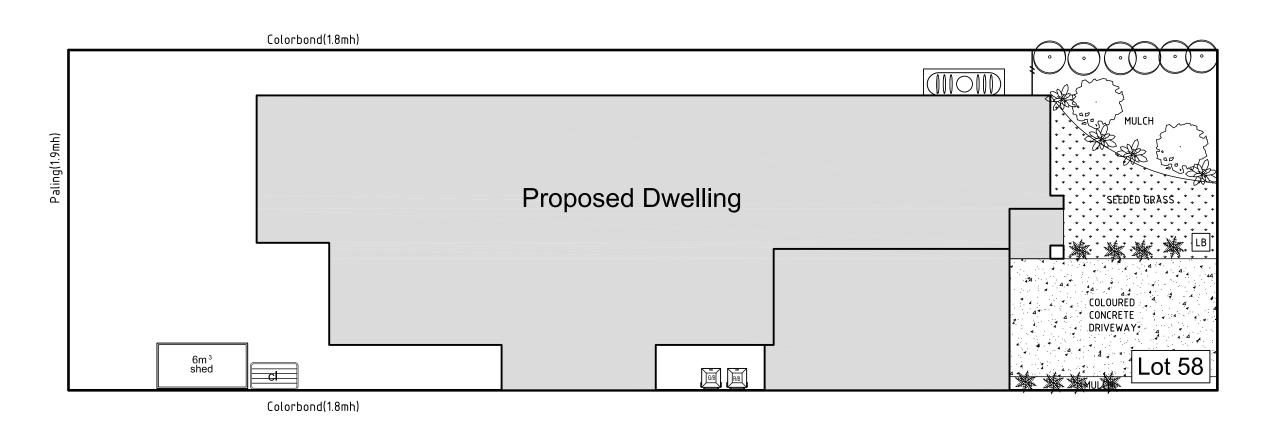
GRANDIFLORA TEDDY BEAR

EXCAVATE A SLOPING SHALLOW PLANTING HOLE, 2-3 TIMES THE WIDTH OF THE ROOT BALL. LEAVE A SPACE BETWEEN MULCH AND TRUNK

of enabling its consideration and review as part of a plan CONGREGES & APPROVED White Planning and Environment Act 1987. The RENDER CHIEF AS SELECTION be used for any purpose which may PROPOSED POLISHED SILVER SLOT.

PLEASE NOTE: The plan/s that
PROPOSED PVC PIPE WITH
PVC PIPE POTIE HED SET TO WEST IS Ultimately they are the most recent version PROPOSED 470mmX470mm RENDERED BRICK LETTERBOX

Letter box



THE NATURE STRIP MUST BE MUST BE COMPLETED IN ORDER FOR THE LANDSCAPE REBATE TO BE PAID

PLEASE NOTE THAT THE AMOUNT OF HARD PAVING USED IN THE FRONT GARDEN, INCLUDING THE DRIVEWAY, MUST NOT COVER MORE THAN 50% OF THE FRONT GARDEN AREA.

PLEASE NOTE THAT AT LEAST 2 ESTABLISHED TREES, EACH WITH AN INSTALLATION HEIGHT OF AT LEAST 2M, MUST BE INSTALLED IN THE FRONT GARDEN, AS PER THE REQUIREMENTS OF SECTION 11 OF THE DESIGN GUIDELINES.

DESCRIPTION

PLANTING TO SIDE BOUNDARIES MUST CONTINUE 4M PAST THE FRONT OF THE HOUSE.

THE HEIGHT OF THE PLANTING TO SIDE FENCES SHOULD BE A MINIMUM 2M.

LANDSCAPE PLAN

Project: PROPOSED RESIDENCE

Lot 58 Mantello Drive. Werribee, Vic, 3030.

Persaud Homes.




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DATE

Date. 28-02-17 Scale. 1:200@A3

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WORKINGTRAWNES
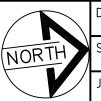
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